




NOTES
1. SIGHT DISTANCE AT MAIN STREET EXIT IS GREATER THAN 500 FT TO THE WEST AND 260 FT TO THE EAST

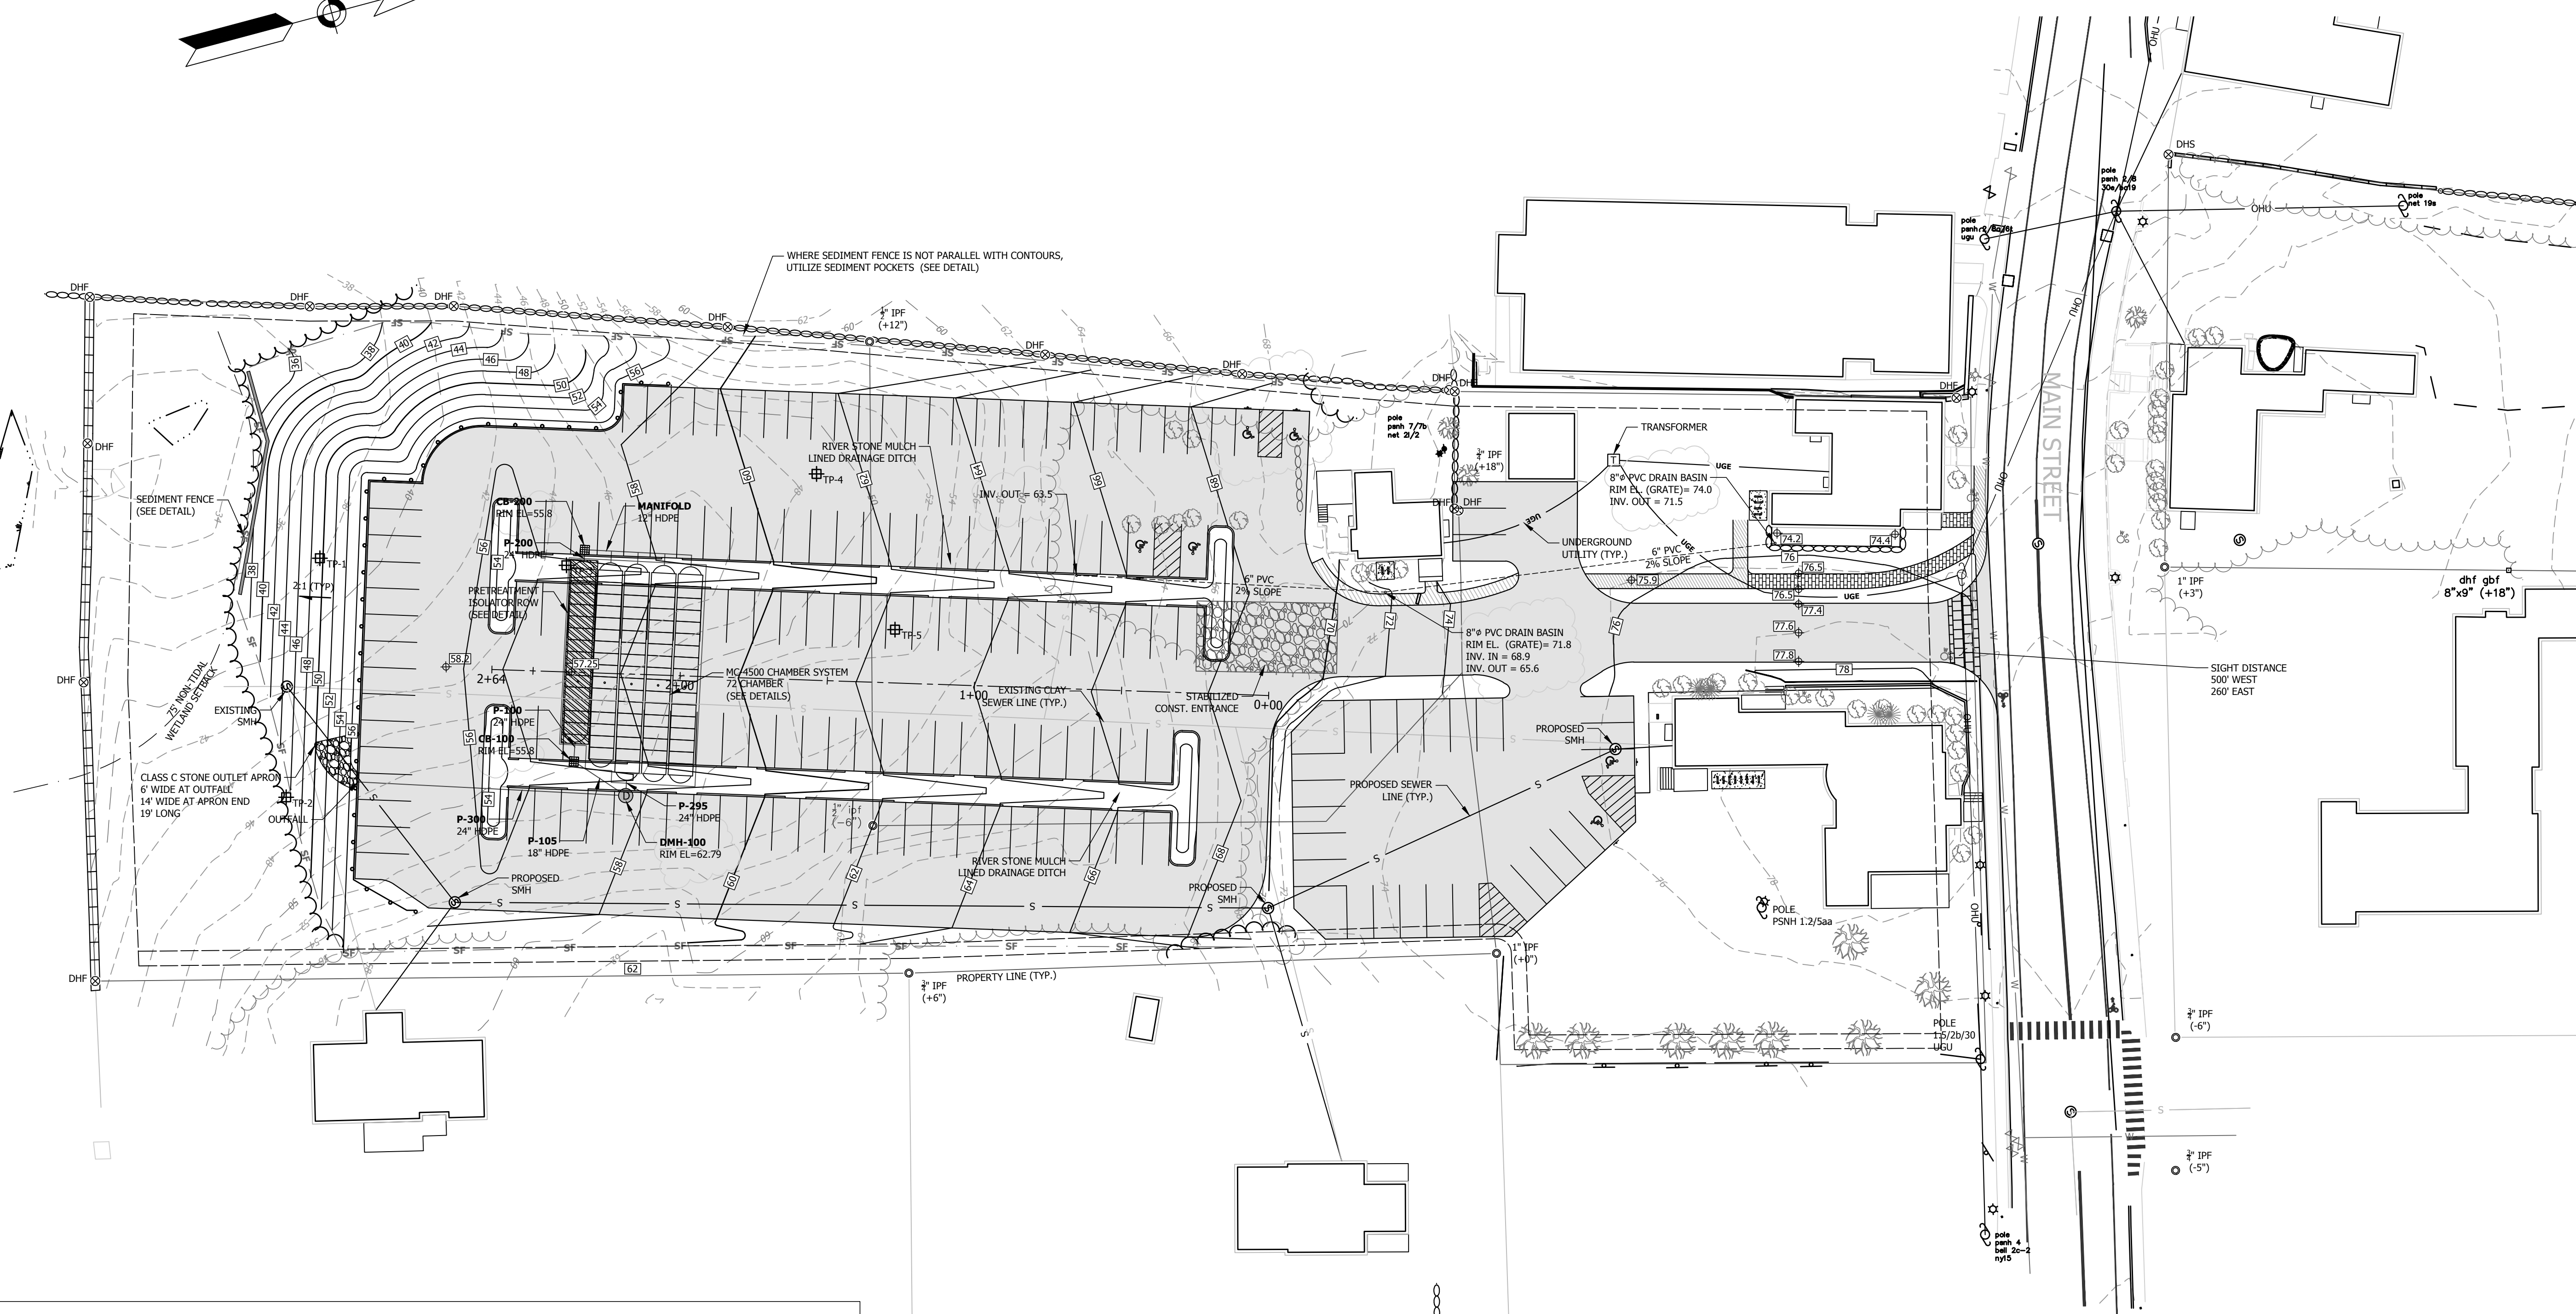

TEST PIT LOGS	
<p>TEST PIT 1:</p> <p>1-0 INCHES PARTIALLY DECOMPOSED ORGANIC MATTER 0-8 INCHES BROWN (10YR 4/3) VERY FINE SANDY LOAM, FRIABLE, GRANULAR 8-11 INCHES LIGHT OLIVE BROWN (2.5Y 5/3) VERY FINE SANDY LOAM, FRIABLE, BLOCKY 11-40 INCHES LIGHT YELLOWISH BROWN (2.5YR 6/3) SILT TO SILT LOAM, FIRM, MASSIVE, COMMON PROMINENT REDOX FEATURES</p> <p>SEASONAL HIGH WATER TABLE @ 11" (PERCHED) OBSERVED WATER TABLE NONE TO 40" RESTRICTIVE HORIZON @ 11" BEDROCK NONE TO 40"</p>	<p>TEST PIT 4:</p> <p>1-0 INCHES PARTIALLY DECOMPOSED ORGANIC MATTER 0-6 INCHES DARK BROWN (10YR 3/3) VERY FINE SANDY LOAM, FRIABLE, GRANULAR 6-11 INCHES DARK YELLOWISH BROWN (10YR 4/4) VERY FINE SANDY LOAM, FRIABLE, BLOCKY 11-40 INCHES LIGHT OLIVE BROWN (2.5Y 5/3) SILT LOAM, FIRM TO VERY FIRM, MASSIVE, COMMON PROMINENT REDOX FEATURES</p> <p>SEASONAL HIGH WATER TABLE @ 11" (PERCHED) OBSERVED WATER TABLE NONE TO 40" RESTRICTIVE HORIZON @ 11" BEDROCK NONE TO 40"</p>
<p>TEST PIT 2:</p> <p>1-0 INCHES PARTIALLY DECOMPOSED ORGANIC MATTER 0-9 INCHES BROWN (10YR 4/3) VERY FINE SANDY LOAM, FRIABLE, GRANULAR 9-12 INCHES DARK YELLOWISH BROWN (10YR 4/4) VERY FINE SANDY LOAM, FRIABLE, BLOCKY 12-22 INCHES LIGHT OLIVE BROWN (2.5Y 5/3) SILT LOAM, FIRM, BLOCKY, COMMON DISTINCT REDOX FEATURES 22-48 INCHES OLIVE GRAY (5Y 4/2) SILT LOAM, VERY FIRM, BLOCKY, COMMON DISTINCT REDOX FEATURES AND MANGANESE STAINS ON PED FACES</p> <p>SEASONAL HIGH WATER TABLE @ 12" (PERCHED) OBSERVED WATER TABLE NONE TO 48" RESTRICTIVE HORIZON @ 12" BEDROCK NONE TO 48"</p>	<p>TEST PIT 5:</p> <p>1-0 INCHES PARTIALLY DECOMPOSED ORGANIC MATTER 0-8 INCHES VERY DARK GRAYISH BROWN (10YR 3/2) VERY FINE SANDY LOAM, FRIABLE, GRANULAR 8-13 INCHES DARK YELLOWISH BROWN (10YR 4/4) VERY FINE SANDY LOAM, FRIABLE, BLOCKY 13-40 INCHES LIGHT OLIVE BROWN (2.5Y 5/3) SILT LOAM, FIRM TO VERY FIRM, MASSIVE, COMMON PROMINENT REDOX FEATURES</p> <p>SEASONAL HIGH WATER TABLE @ 13" (PERCHED) OBSERVED WATER TABLE NONE TO 40" RESTRICTIVE HORIZON @ 13" BEDROCK NONE TO 40"</p>
<p>TEST PIT 3:</p> <p>1-0 INCHES PARTIALLY DECOMPOSED ORGANIC MATTER 0-8 INCHES BROWN (10YR 4/3) VERY FINE SANDY LOAM, FRIABLE, GRANULAR 8-13 INCHES DARK YELLOWISH BROWN (10YR 4/4) VERY FINE SANDY LOAM, FRIABLE, BLOCKY 13-43 INCHES LIGHT OLIVE BROWN (2.5Y 5/3) SILT LOAM, FIRM TO VERY FIRM, MASSIVE, COMMON PROMINENT REDOX FEATURES</p> <p>SEASONAL HIGH WATER TABLE @ 13" (PERCHED) OBSERVED WATER TABLE NONE TO 43" RESTRICTIVE HORIZON @ 13" BEDROCK NONE TO 43"</p>	

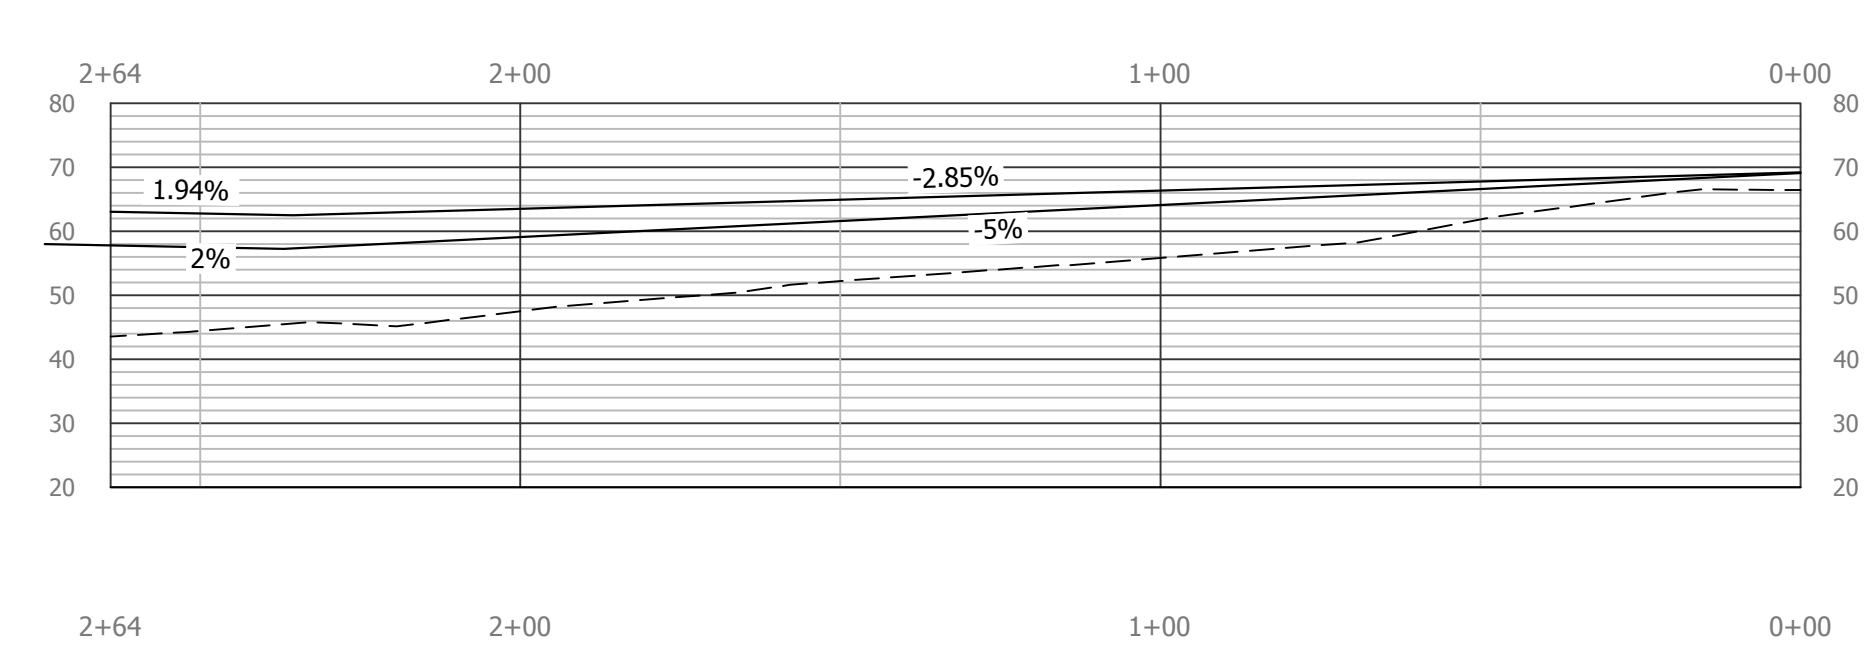

P- PARKING LOT - CL
STA: 0+00 TO STA: 2+64

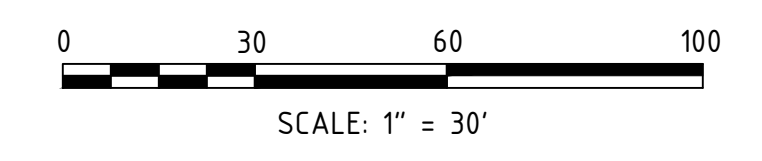

FINAL APPROVAL BY DURHAM PLANNING BOARD.
CERTIFIED BY MICHAEL BEHRENDT, TOWN PLANNER
CERTIFIED _____
DATE _____

REVISED GRADING, DRAINAGE, UTILITY & EROSION CONTROL PLAN prepared for TOOMERS, LLC TAX MAP 5, LOTS 1-9 AND 1-10 19 MAIN ST AND 21 MAIN ST, DURHAM, NH 03824		DATE ISSUED: 05/06/21 SCALE: 1"=30' DESIGNED BY: AMS DRAWN BY: AMS APPROVED BY: MJS DWG FILE: 18041 CIVIL_02.dwg	NO. _____ REVISIONS
			DATE INT. 05/06/21 DATE INT. 05/06/21 DATE INT. 05/06/21
			JOB: 18-041
			C-102