




**NOTES**  
1. SIGHT DISTANCE AT MAIN STREET EXIT IS GREATER THAN 500 FT TO THE WEST AND 260 FT TO THE EAST

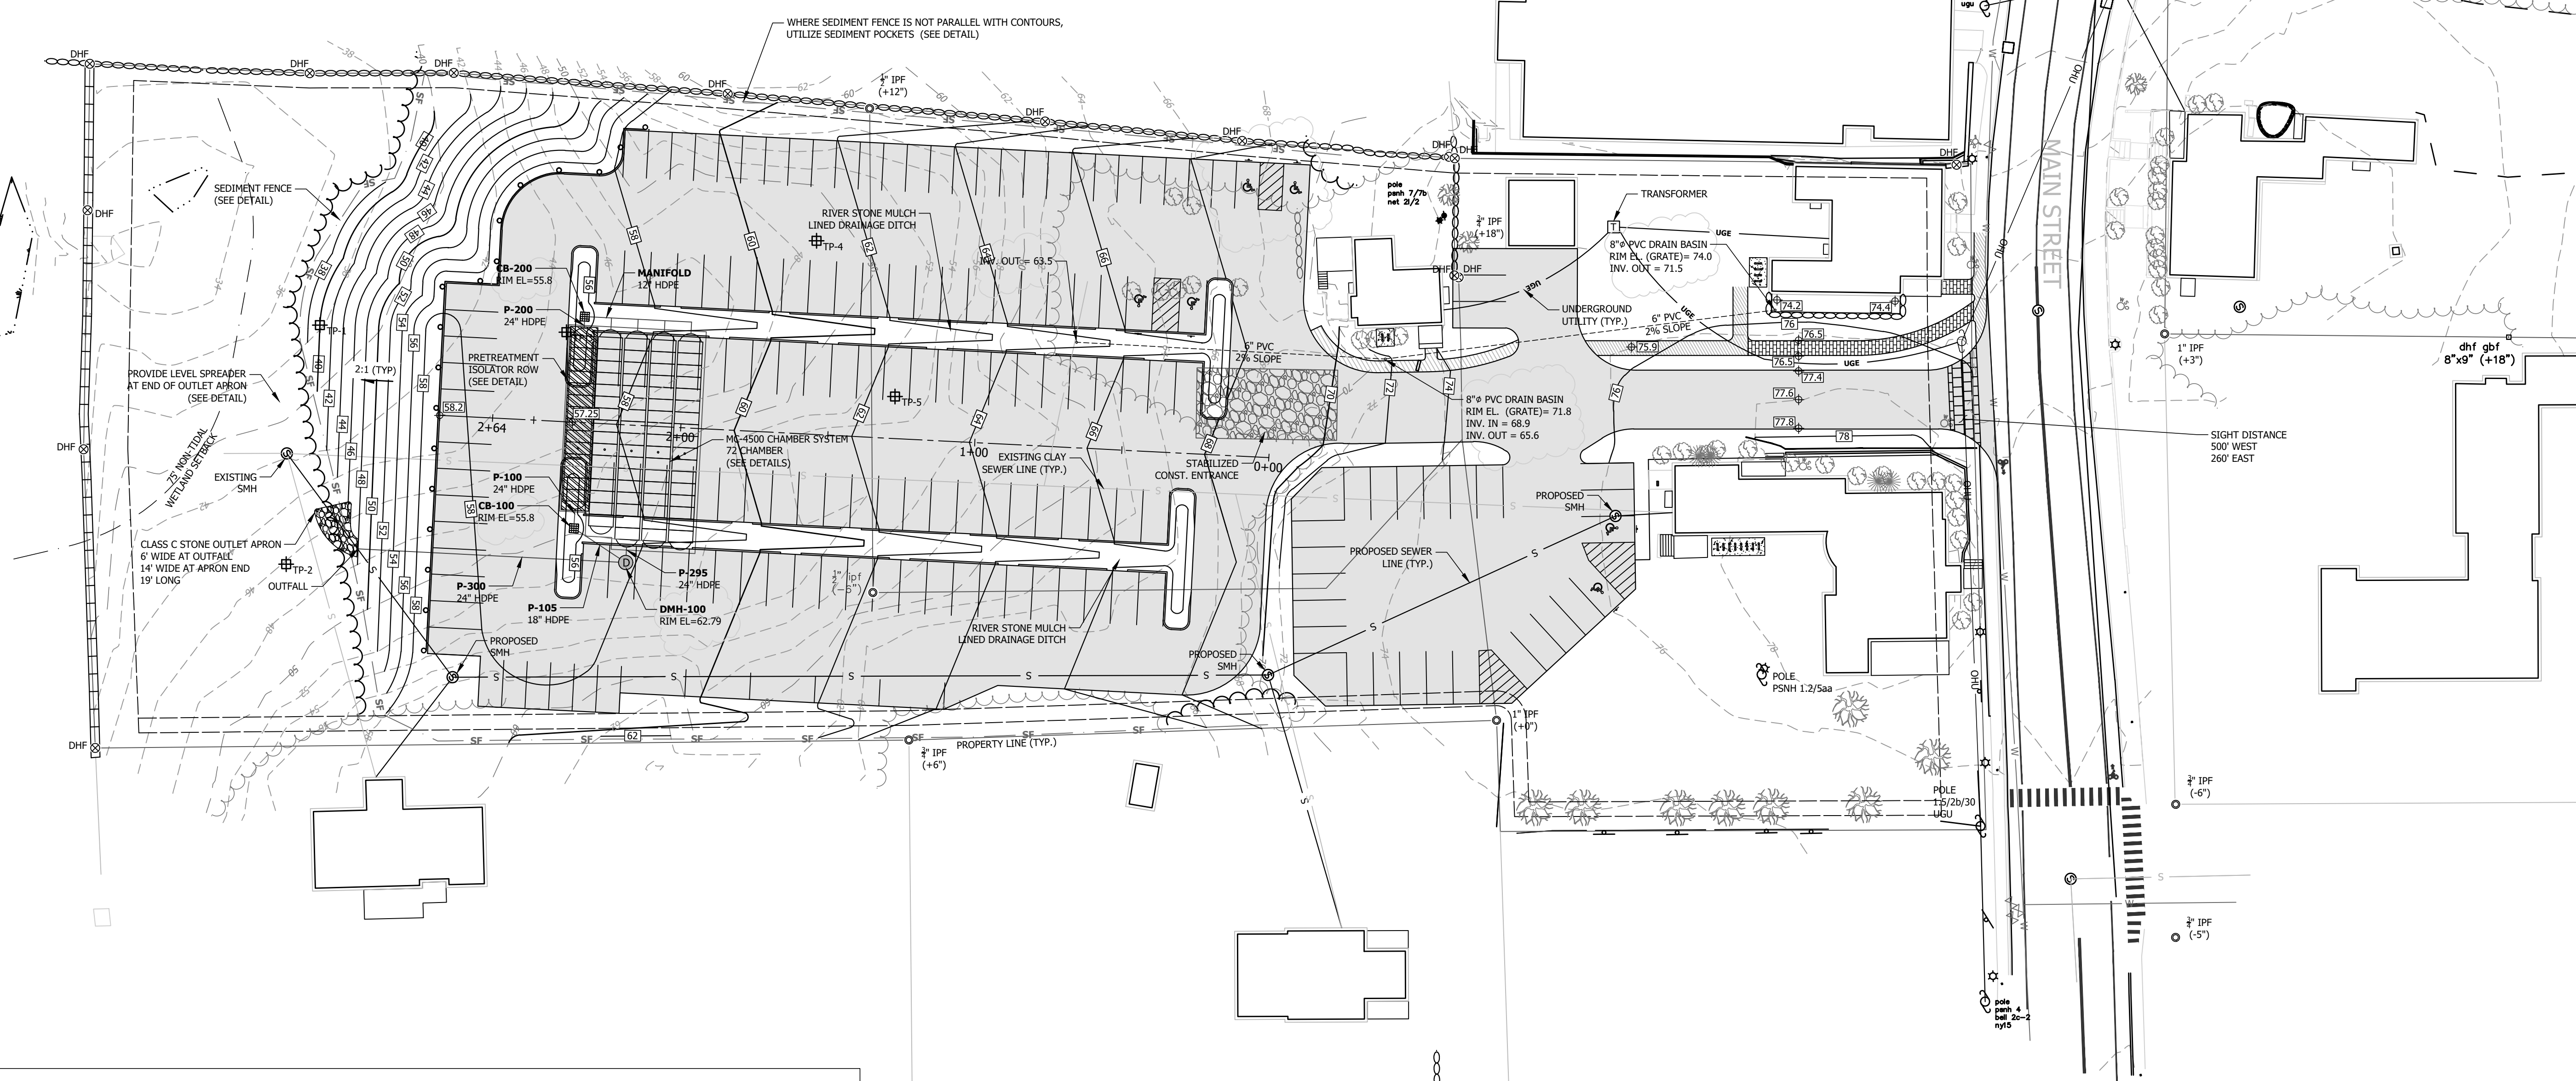

TEST PIT LOGS	
<p><b>TEST PIT 1:</b></p> <p>1-0 INCHES PARTIALLY DECOMPOSED ORGANIC MATTER 0-8 INCHES BROWN (10YR 4/3) VERY FINE SANDY LOAM, FRIABLE, GRANULAR 8-11 INCHES LIGHT OLIVE BROWN (2.5Y 5/3) VERY FINE SANDY LOAM, FRIABLE, BLOCKY 11-40 INCHES LIGHT YELLOWISH BROWN (2.5YR 6/3) SILT TO SILT LOAM, FIRM, MASSIVE, COMMON PROMINENT REDOX FEATURES</p> <p>SEASONAL HIGH WATER TABLE @ 11\"/&gt; </p>	<p><b>TEST PIT 4:</b></p> <p>1-0 INCHES PARTIALLY DECOMPOSED ORGANIC MATTER 0-6 INCHES DARK BROWN (10YR 3/3) VERY FINE SANDY LOAM, FRIABLE, GRANULAR 6-11 INCHES DARK YELLOWISH BROWN (10YR 4/4) VERY FINE SANDY LOAM, FRIABLE, BLOCKY 11-40 INCHES LIGHT OLIVE BROWN (2.5Y 5/3) SILT LOAM, FIRM TO VERY FIRM, MASSIVE, COMMON PROMINENT REDOX FEATURES</p> <p>SEASONAL HIGH WATER TABLE @ 11\"/&gt; </p>
<p><b>TEST PIT 2:</b></p> <p>1-0 INCHES PARTIALLY DECOMPOSED ORGANIC MATTER 0-9 INCHES BROWN (10YR 4/3) VERY FINE SANDY LOAM, FRIABLE, GRANULAR 9-12 INCHES DARK YELLOWISH BROWN (10YR 4/4) VERY FINE SANDY LOAM, FRIABLE, BLOCKY 12-22 INCHES LIGHT OLIVE BROWN (2.5Y 5/3) SILT LOAM, FIRM, BLOCKY, COMMON DISTINCT REDOX FEATURES 22-48 INCHES OLIVE GRAY (5Y 4/2) SILT LOAM, VERY FIRM, BLOCKY, COMMON DISTINCT REDOX FEATURES AND MANGANESE STAINS ON PED FACES.</p> <p>SEASONAL HIGH WATER TABLE @ 12\"/&gt; </p>	<p><b>TEST PIT 5:</b></p> <p>1-0 INCHES PARTIALLY DECOMPOSED ORGANIC MATTER 0-8 INCHES VERY DARK GRAYISH BROWN (10YR 3/2) VERY FINE SANDY LOAM, FRIABLE, GRANULAR 8-13 INCHES DARK YELLOWISH BROWN (10YR 4/4) VERY FINE SANDY LOAM, FRIABLE, BLOCKY 13-40 INCHES LIGHT OLIVE BROWN (2.5Y 5/3) SILT LOAM, FIRM TO VERY FIRM, MASSIVE, COMMON PROMINENT REDOX FEATURES</p> <p>SEASONAL HIGH WATER TABLE @ 13\"/&gt; </p>
<p><b>TEST PIT 3:</b></p> <p>1-0 INCHES PARTIALLY DECOMPOSED ORGANIC MATTER 0-8 INCHES BROWN (10YR 4/3) VERY FINE SANDY LOAM, FRIABLE, GRANULAR 8-13 INCHES DARK YELLOWISH BROWN (10YR 4/4) VERY FINE SANDY LOAM, FRIABLE, BLOCKY 13-43 INCHES LIGHT OLIVE BROWN (2.5Y 5/3) SILT LOAM, FIRM TO VERY FIRM, MASSIVE, COMMON PROMINENT REDOX FEATURES</p> <p>SEASONAL HIGH WATER TABLE @ 13\"/&gt; </p>	

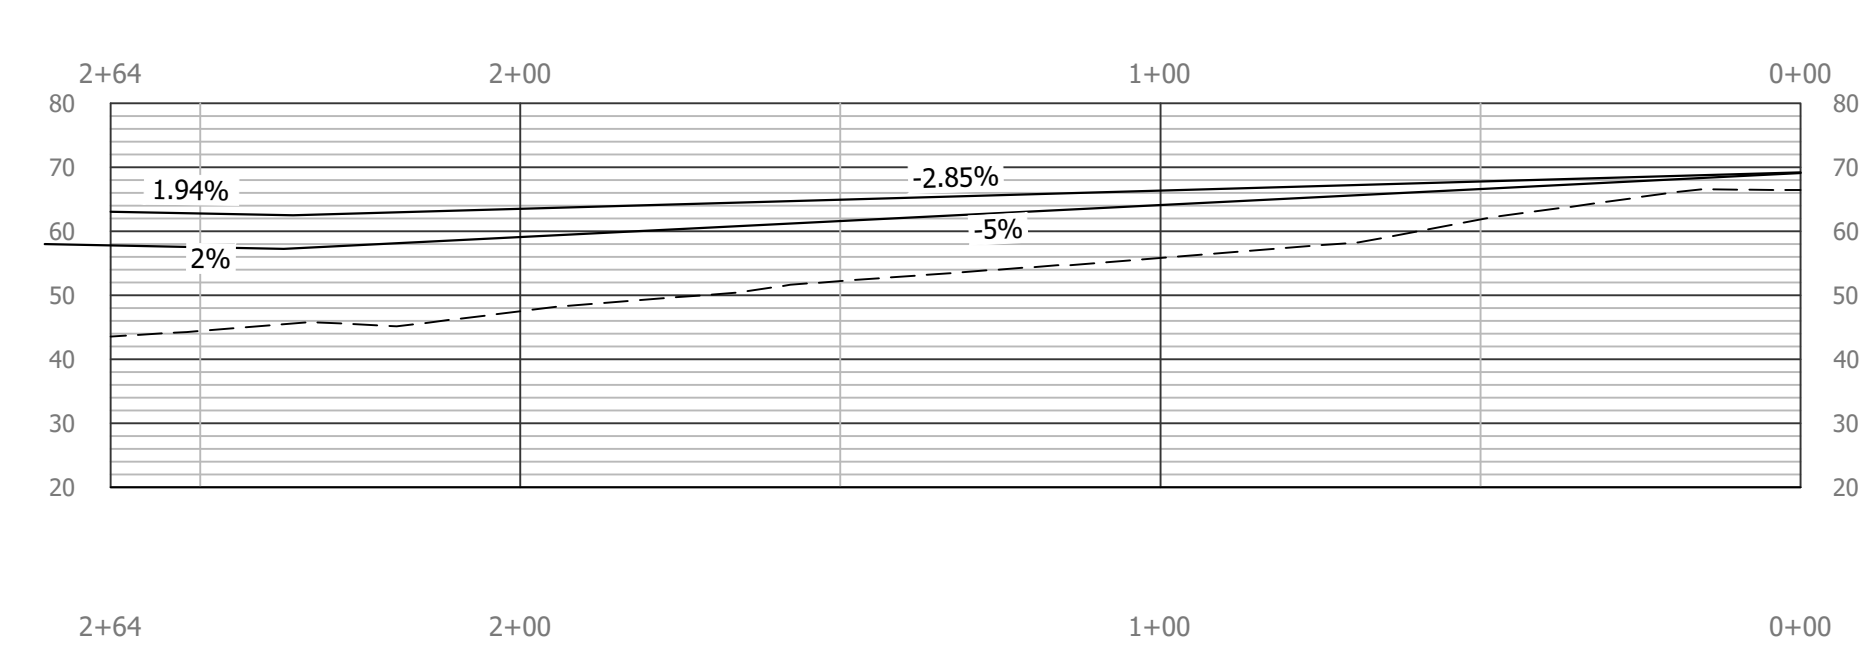

P- PARKING LOT - CL  
STA: 0+00 TO STA: 2+64

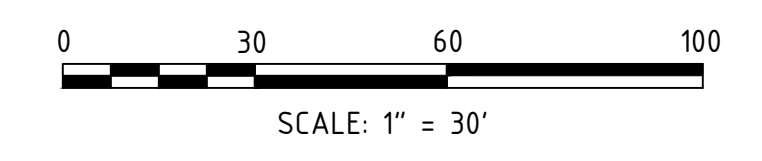

FINAL APPROVAL BY DURHAM PLANNING BOARD.  
CERTIFIED BY MICHAEL BEHRENDT, TOWN PLANNER  
CERTIFIED \_\_\_\_\_  
DATE \_\_\_\_\_

REVISED GRADING, DRAINAGE, UTILITY & EROSION CONTROL PLAN prepared for TOOMERFS, LLC TAX MAP 5, LOTS 1-9 AND 1-10 19 MAIN ST AND 21 MAIN ST, DURHAM, NH 03824		DATE ISSUED: 05/06/21 SCALE: 1"=30' DESIGNED BY: AWS DRAWN BY: AWS APPROVED BY: MJS DWG FILE: 18041 EMISS - NEW GRADING ALT-2.dwg								
<p><b>MJS ENGINEERING, P.C.</b> CIVIL • STRUCTURAL • ENVIRONMENTAL</p> <p>5 RAILROAD ST., P.O. BOX 359 NEWBURY, NH 03857 PHONE: (603) 659-4070 FAX: (603) 659-4027 E-MAIL: <a href="mailto:info@mjs-engineering.com">info@mjs-engineering.com</a></p>		<table border="1"> <tr> <th>NO.</th> <th>REVISIONS</th> <th>DATE</th> <th>INT.</th> </tr> <tr> <td>0</td> <td>INITIAL REVISED DESIGN SUBMISSION</td> <td>05/06/21</td> <td>AWS</td> </tr> </table>	NO.	REVISIONS	DATE	INT.	0	INITIAL REVISED DESIGN SUBMISSION	05/06/21	AWS
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0	INITIAL REVISED DESIGN SUBMISSION	05/06/21	AWS							
<p>REVISIONS</p>		<p>SEAL</p>								
<p>JOB: 18-041</p>		<p>C-102</p>								