

Landscape Notes

- 1. Design is based on drawings by MJS Engineering dated 12/4/2020 and may require adjustment due to actual field conditions.

 2. The contractor shall follow best management practices during construction and shall take all means necessary to stabilize and protect the site from erosion.

 3. Erosion Control to consist of Hay Bales and Erosion Control Fabric shall be staked in place between the work and Water bodies, Wetlands and/or drainage ways prior to any construction.

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 5. The Contractor shall verify layout and grades and inform the Landscape Architect or Client's Representative of any discrepancies or changes in layout and/or grade relationships prior to construction.

 6. It is the contractor's responsibility to verify drawings provided are to the correct scale prior to any bid, estimate or installation. A graphic scale bar has been provided on each sheet for this purpose. If it is determined that the scale of the drawing is incorrect, the landscape architect or this purpose. If it is determined that the scale of the contractor.

 7. Trees to Remain within the construction zone shall be protected from damage for the duration of the project by snow fence or other suitable means of protection to be approved by Landscape Architect or Client's Representative. Snow fence shall be located at the drip line at a minimum and shall include any and all surface roots. Do not fill or mulch on the trunk flare. Do not disturb roots. In order to protect the integrity of the roots, branches, trunk and bark of the tree(s) no vehicles or construction equipment shall drive or park in or on the area within the drip line(s) of the tree(s). Do not store any refuse or construction materials or portalets within the tree protection area.

 8. Location, support, protection, and restoration of all existing utilities and appurtenances shall be the responsi

- Contaction, support, protection, and restoration of all existing lumines and expositive utility owners prior to construction.
 The Contractor shall verify exact location and elevation of all utilities with the respective utility owners prior to construction.
 DiGSAFE at 1-888-344-733.
 The Contractor shall procure any required permits prior to construction.
 Prior to any landscape construction activities contractor shall exist all existing loam and loam from off-site intended to be used for lawns and plant beds using a thorough sampling throughout the supply. Soil testing shall indicate levels of ph. Intracts results and recommendations from the testing facility along with soil amendment plans as recessary for the proposed plantings to thrive. All learn to be used on site shall be amended as approved by the Landscape Architect with test results and recommendations from the testing facility along with soil amendment plans as recessary for the proposed plantings to thrive.
 Contractor shall mortly landscape architect or owner's representative immediately if at any point during demolition or construction a site condition is discovered which may regatively impact the completed project. This includes, but is not under contractor shall furnish and plant all plants shall produce the testing facility along with soil amendment plant as the plant and the site. If a representative immediately in the plant shall be plant shall be plant and plant all plants shall conform to the boardscape and the site. If a representative immediately his plant plant and plant all conforms to the boardscape and shall produce the plant and plant all conforms on the boardscape and shall produce the event that quantity discrepancies or material missions occur in the plant materials is the plant and association to the boardscape and size of plants in all plants and plant and rejection during or affer the progress of the work. The Owner reserves the right to inspect and/or s


20. 21.

- Drip strip shall extend to 6" beyond roof overhang and shall be edged with 3/16" thick metal edger. In no case shall mulch touch the stem of a plant nor shall mulch ever be more than 3" thick total (including previously applied mulch) over the root ball of any plant.


 Secondary lateral branches of deciduous trees overhanging vehicular and pedestrian travel ways shall be pruned up to a height of 6' to allow clear and safe passage of vehicles and pedestrians under tree canopy. Within the sight distance triangles at vehicle intersections the canopies shall be raised to 8' min.


 Snow shall be stored a minimum of 5' from shrubs and trunks of trees.

 Landscape Architect is not responsible for the means and methods of the contractor.

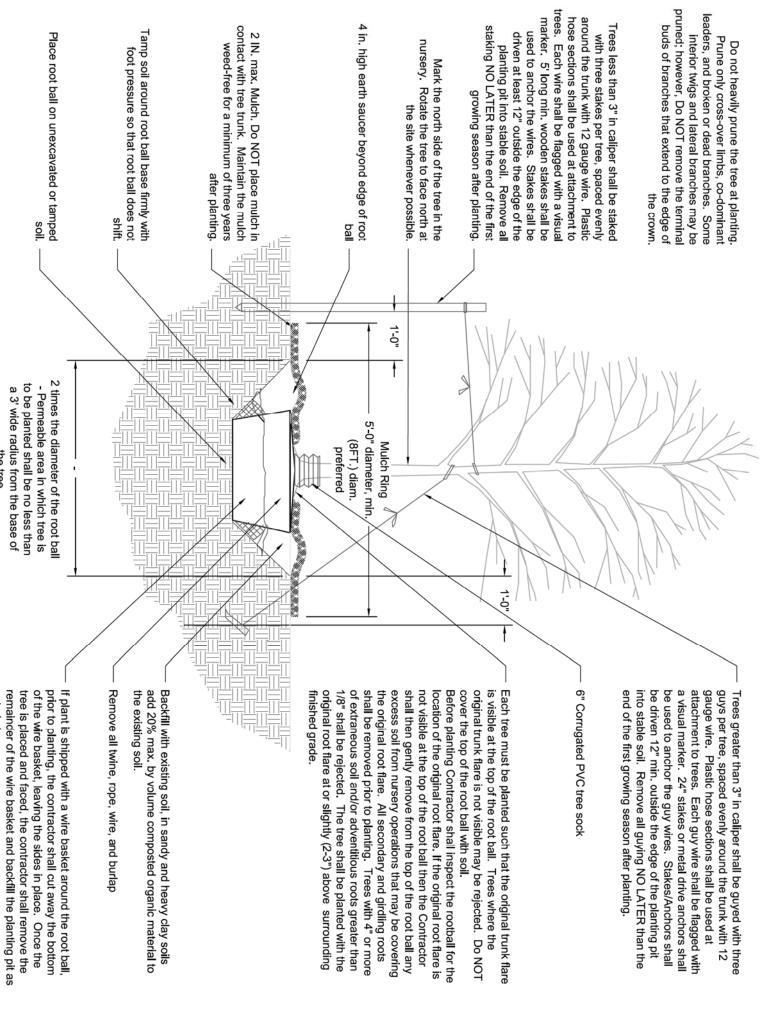

Tree Planting Detail

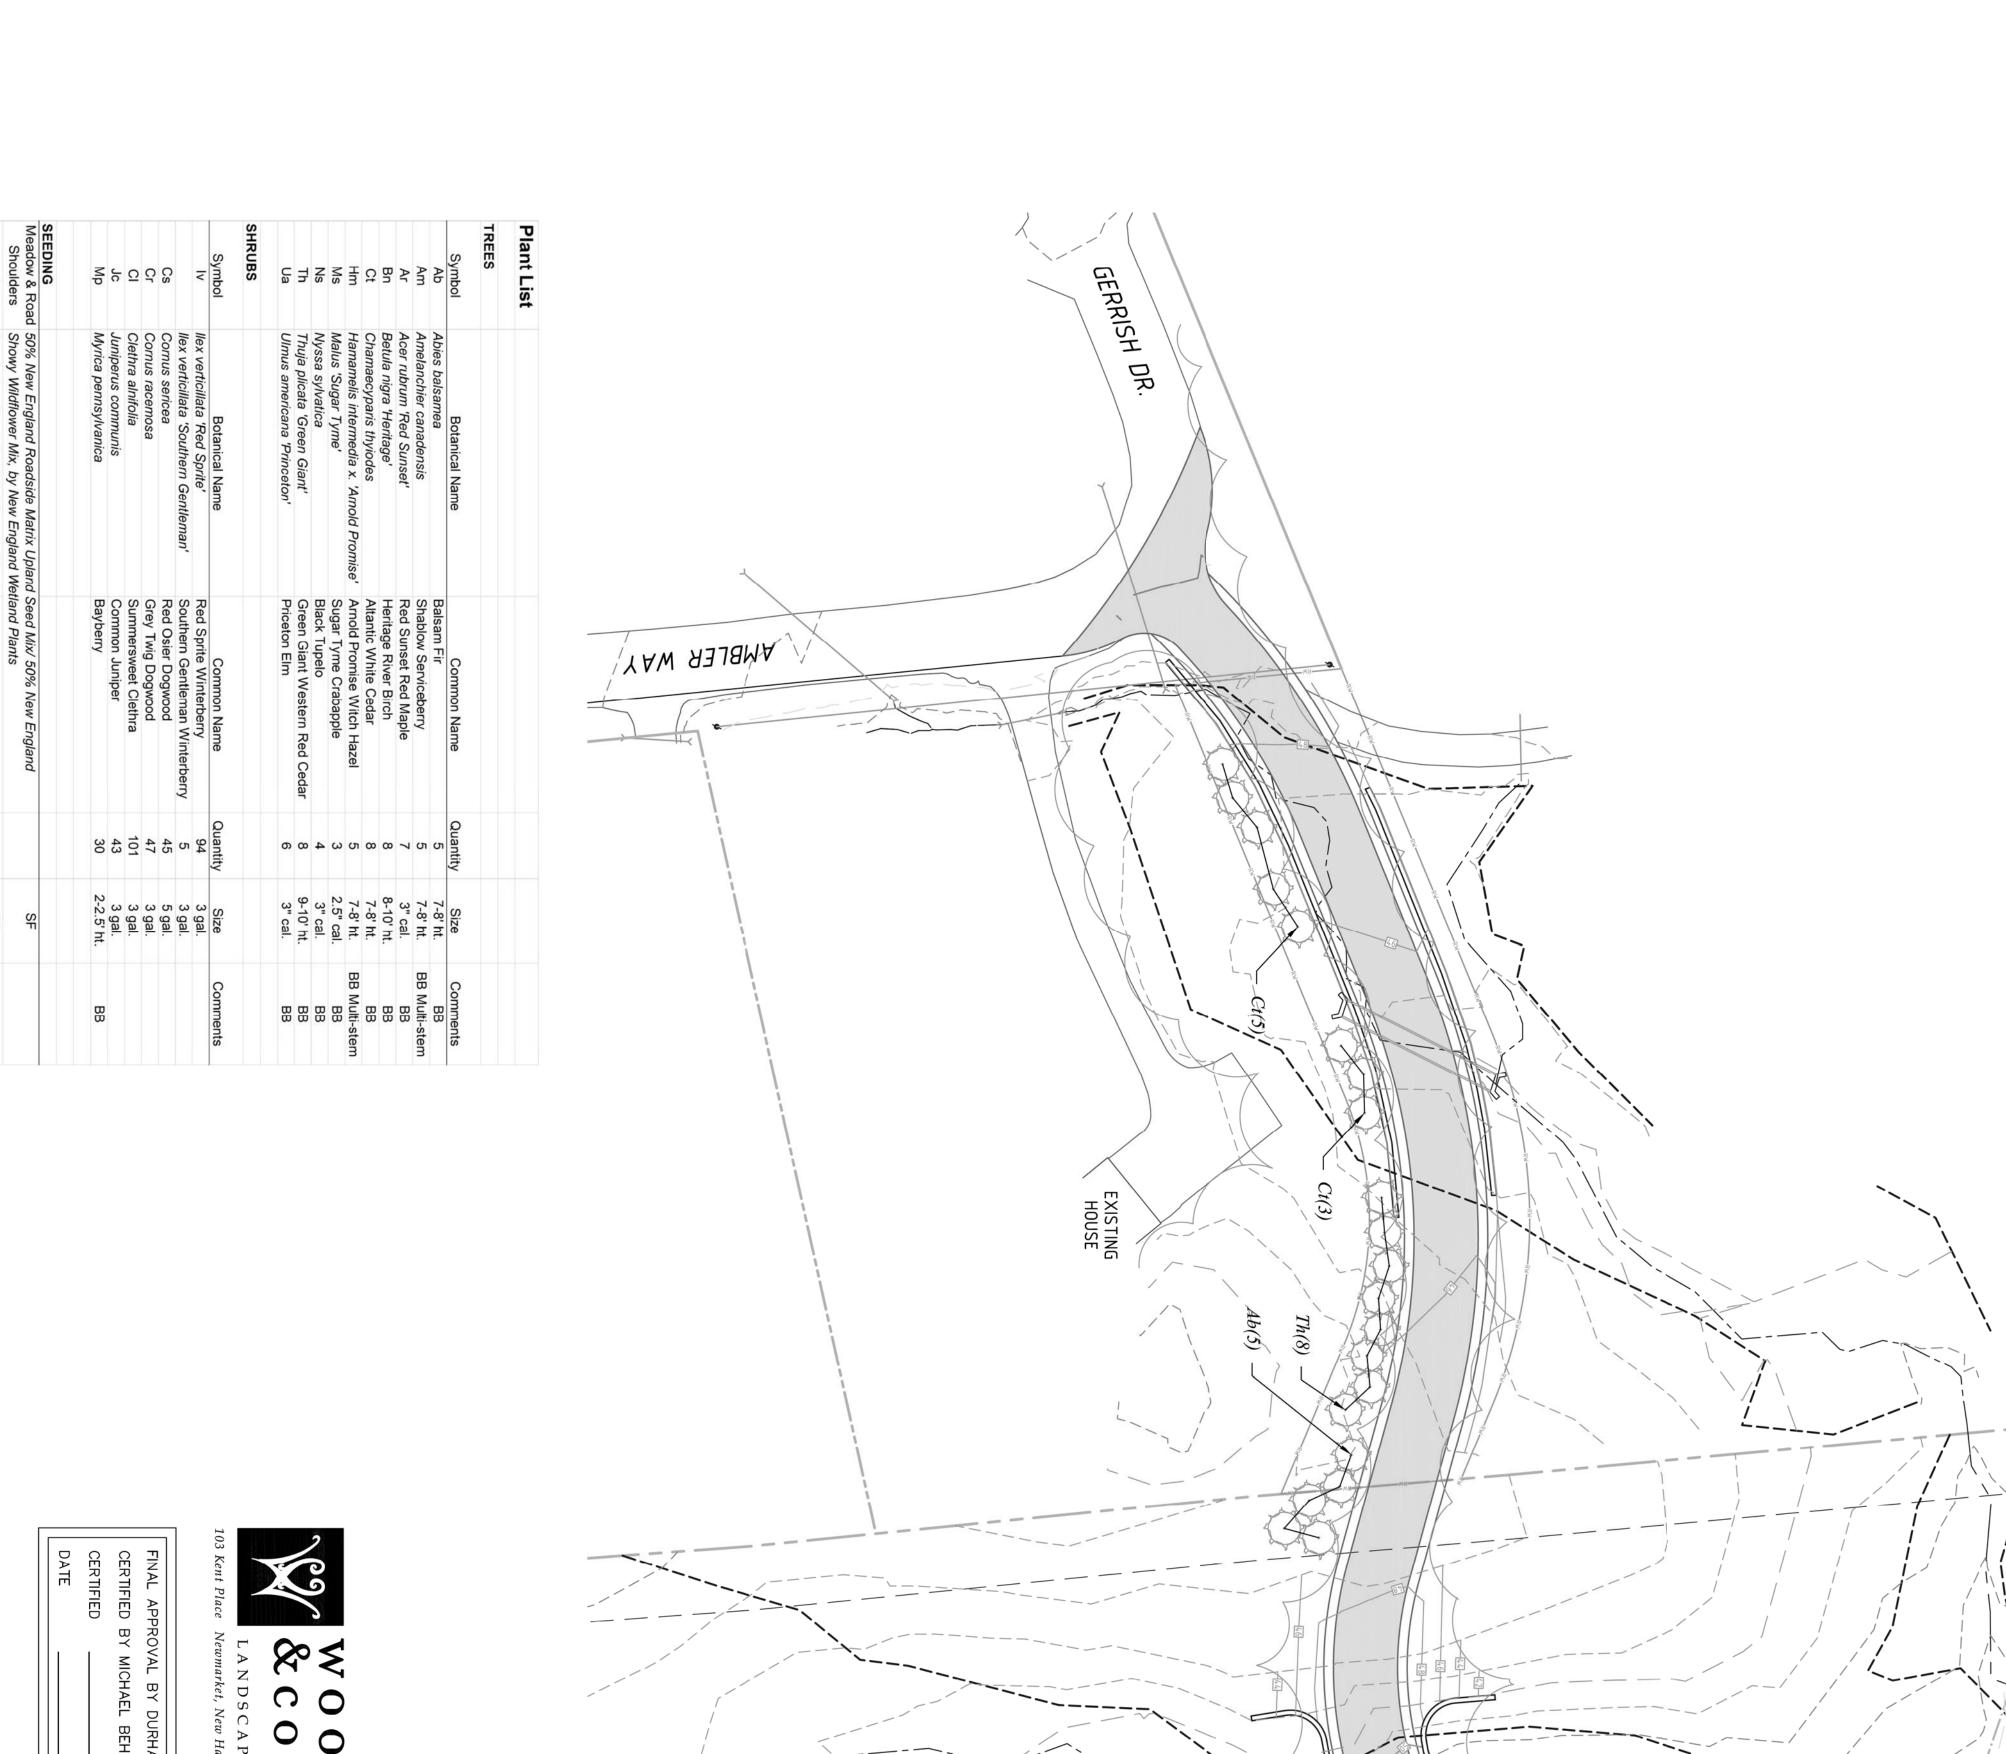

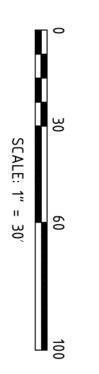

MJS	ENGINEERING, P.C. CIVIL • STRUCTURAL • ENVIRONMENTAL
	5 Railroad St., P.O. Box 359

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Phone: (603) 659-4979, Fax: (603) 659-4627

E-mail: mjs@mjs-engineering.com

prepared for MULHERN TAX MAP 10, LOT 8-6 93 BAGDAD ROAD, DURHAM, NH 03824

DATE ISSUED:	12/09/20
SCALE:	1"=30'
DESIGNED BY:	RW
DRAWN BY:	VM
APPROVED BY:	RW
DWG FILE:	

SEAL

1.	REVISED SUBMISSION TO THE DURHAM PLANNING BOARD	12/09/20	VM
0.	INITIAL SUBMISSION TO THE DURHAM PLANNING BOARD		MCS
NO.	REVISIONS	DATE	INT.

ARATCH LINE SHEET LIOO

LANDSCAPE PLAN PLAN