
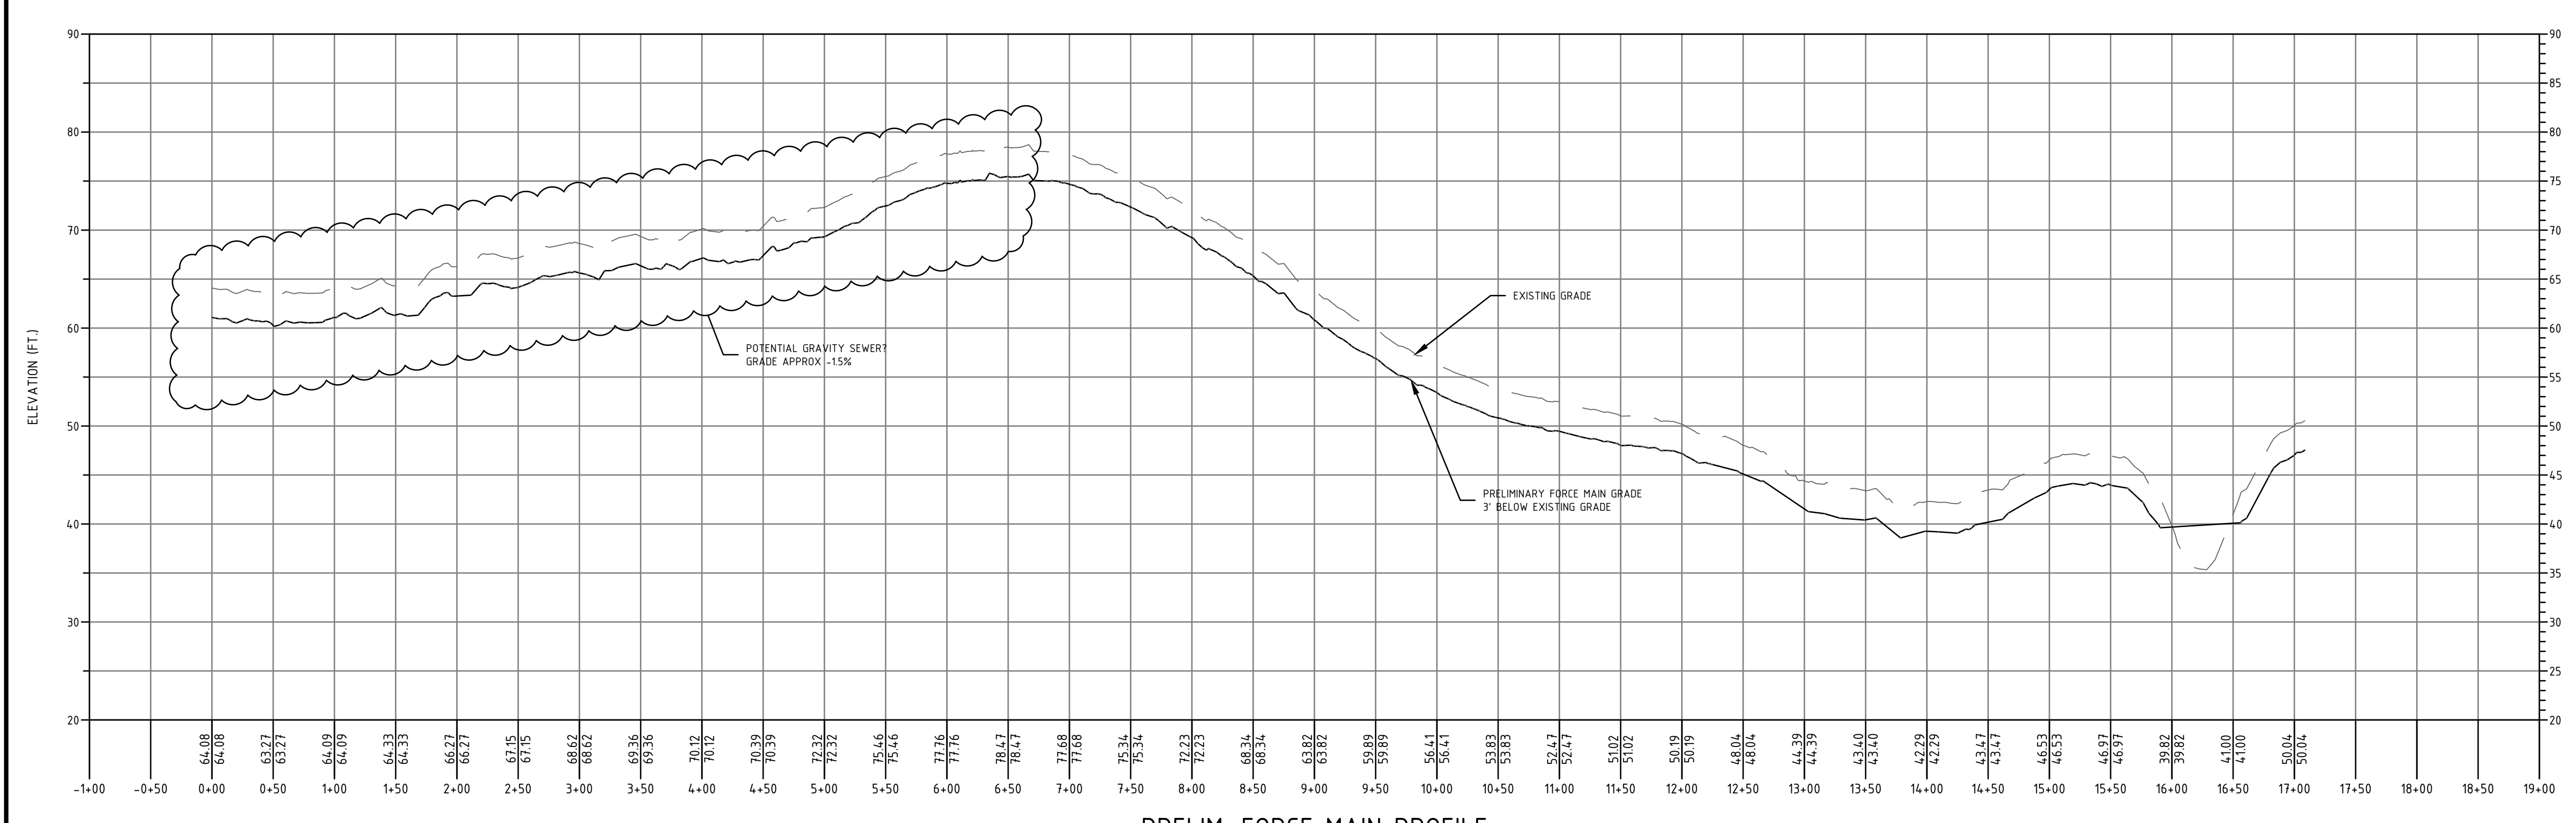
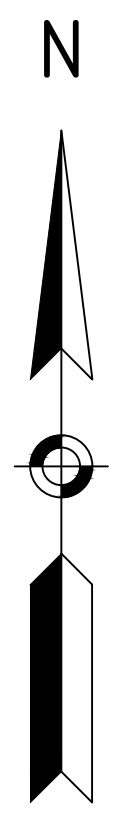
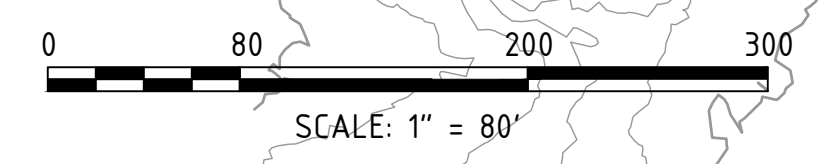


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Mon, 09 Mar 2020 - 3:44pm

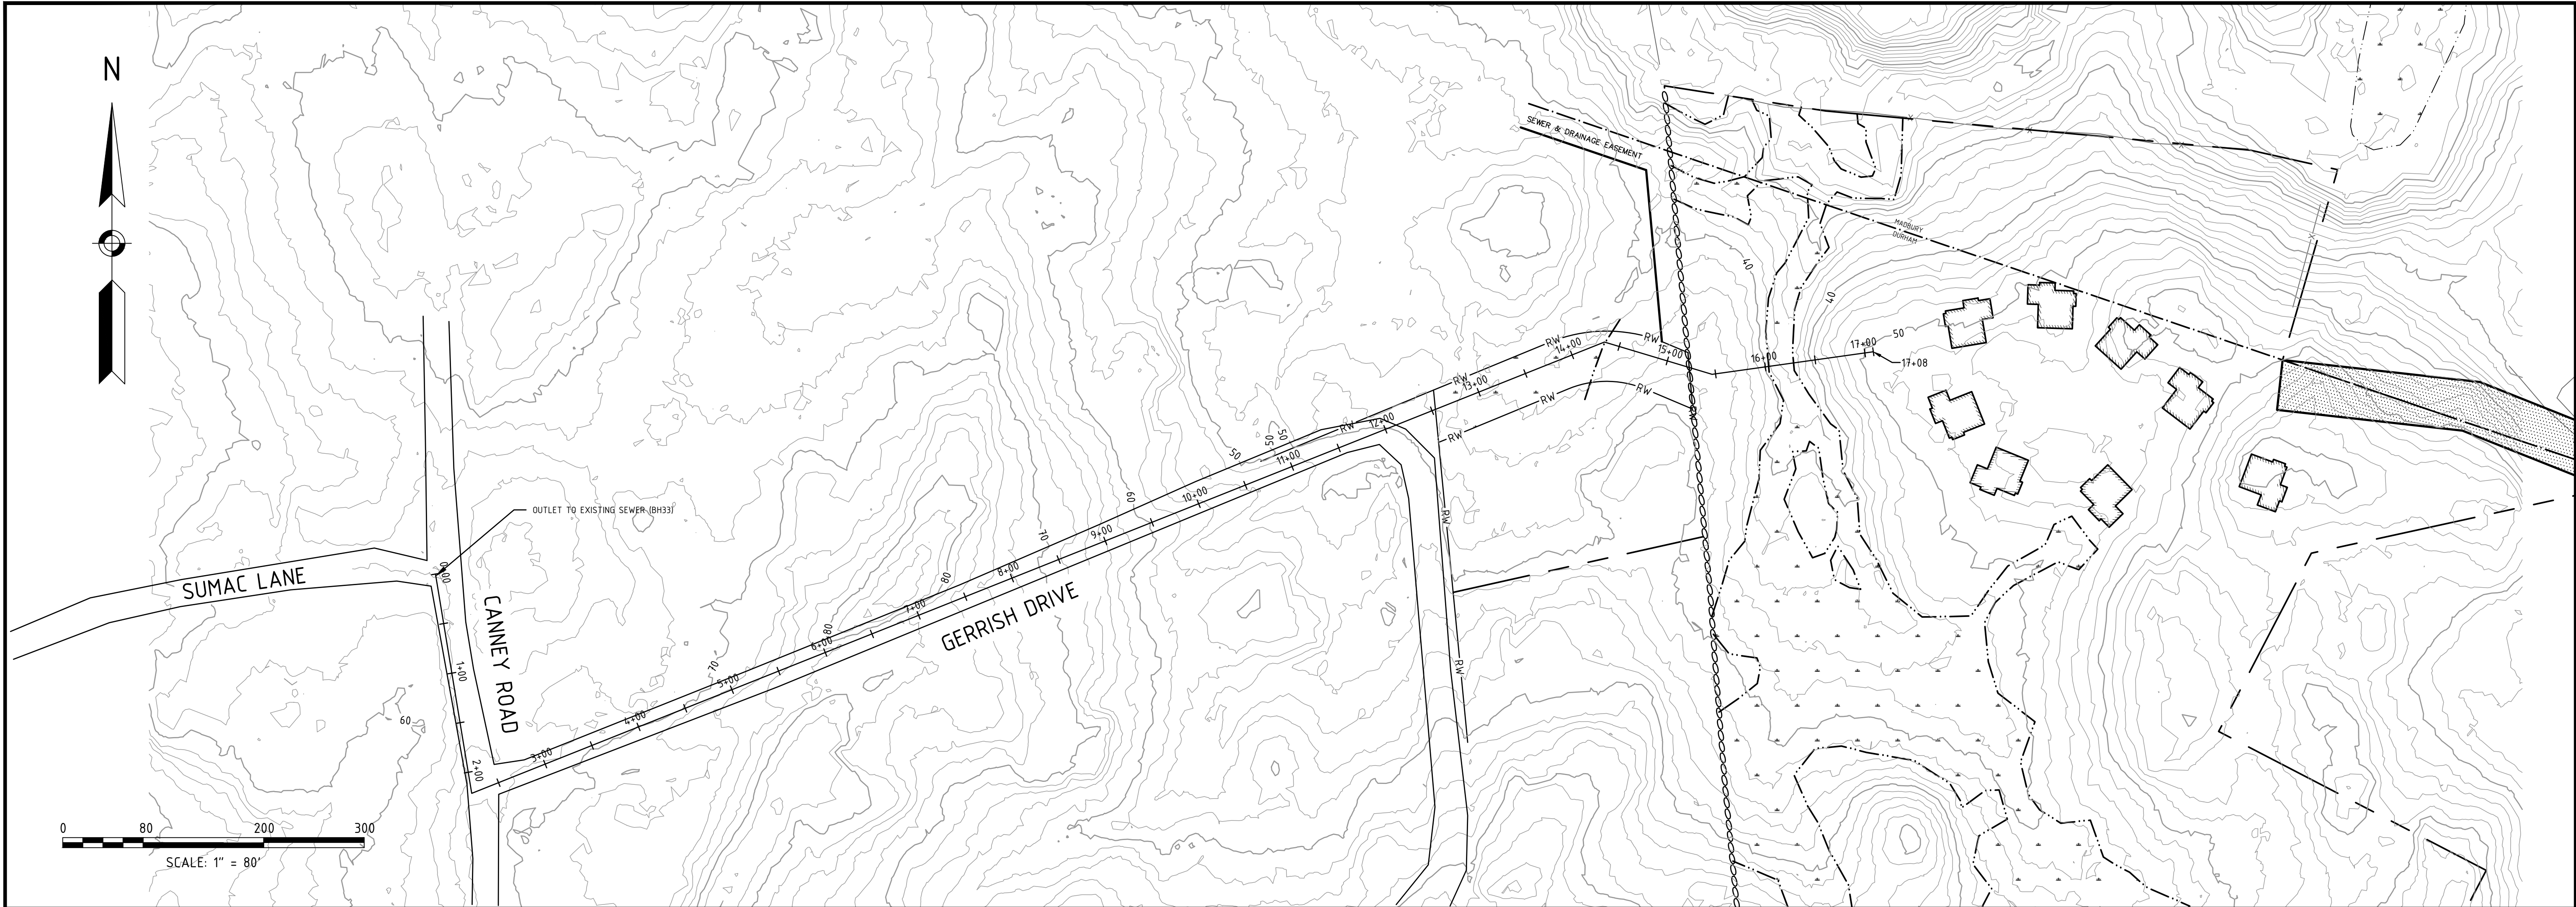

PRELIM. FORCE MAIN PROFILE

VERTICAL EXAGGERATION: 8
HORIZONTAL SCALE: 1"=80'
VERTICAL SCALE: 1"=10'

- NOTES:
1. THE PURPOSE OF THIS DRAWING IS TO SHOW THE APPROXIMATE EXISTING ELEVATIONS ALONG A CONCEPTUAL FORCE MAIN FOR EVALUATION PURPOSES ONLY.
 2. VERTICAL DATA IS TAKEN FROM LIDAR DATA COLLECTED IN 2011 AND ACCESSED FROM GRANTM1.

<p>CONCEPTUAL FORCE MAIN PLAN AND PROFILE prepared for MICHAEL & MARTHA MULHREN MAP 10, LOT 8-6 91 BAGDAD ROAD DURHAM, NH 03824</p>	<p>MJS ENGINEERING PC CIVIL • STRUCTURAL • ENVIRONMENTAL 5 HALLAMDALE ST., SUITE 309 DURHAM, NH 03824 PHONE: (603) 659-4979, FAX: (603) 659-4627 E-MAIL: MJS@MJE-ENGINEERING.COM</p>
<p>DATE: 3/9/20 SCALE: 1"=80' DESIGNED BY: MJS DRAWN BY: MCS APPROVED BY: MJS DWG FILE: 19063_Civil.dwg</p>	<p>SEAL</p>
<p>NO. _____</p>	<p>REVISIONS</p>
<p>DATE: 3/9/20</p>	<p>DATE: INT.</p>
<p>JOB: 19-063</p>	
<p style="font-size: 2em;">SK1</p>	